



PROVINCE OF BENGUET
 La Trinidad
BIDS AND AWARDS COMMITTEE
 (INFRASTRUCTURE PROJECTS)

Project Number GF 22040

MEMORANDUM TO:

Mr. / Ms.: BAC SUPPORT STAFF
 (Canvasser)

Please furnish each of the following dealer/ establishment a copy of the solicitation "bid" tender for the project
IMPROVEMENT OF JFMR - LLPB - LANAS - PUSONG ROAD, PUSONG, LOO, BUGUIAS
 for use of BUGUIAS, BENGUET to be opened on March 7, 2022 at 9:00AM ABC: 1,000,000.00

	NAME OF CONSTRUCTION FIRM	ADDRESS	RECEIVED	DATE
1				
2				
3				
4				
5				
6				
7				
8				
9				
10				


ATTY. SUNNY G. SACLA
 BAC - INFRA Chairperson

CERTIFICATION

I/We the undersigned, hereby jointly and severally certify to have given each of the above contractor/establishments a copy of the solicitation bid papers and inform them that they shall submit their quotations before the time of opening of the same.

CANVASSER/S:

CEFERINO GOLINGAB JR. / SEVENTINA C. OWAY
 BAC SUPPORT STAFF



Republic of the Philippines
PROVINCE OF BENGUET
La Trinidad
BIDS AND AWARDS COMMITTEE
(INFRASTRUCTURE PROJECTS)

Project Number: GF 22040 Source of Fund: GF CY 2022
Name of the Project: IMPROVEMENT OF JFMR - LLPB - LANAS - PUSONG ROAD, PUSONG, LOO, BUGUIAS No. of Calendar Days: 48
Location of the Project: BUGUIAS, BENGUET ABC: 1,000,000.00

**REQUEST FOR QUOTATION
NEGOTIATED PROCUREMENT- (SMALL VALUE PROCUREMENT)**

Sir/Madam:

Please quote your lowest price on the project listed below. Please Submit your Quotation duly signed by you to the Bids and Awards Committee not later than **8:30 AM on March 7, 2022** c/o BAC Support, 2nd Floor, BAC Office, Capitol La Trinidad. To be opened at **9:00am** on the same day.
Thank you very much.


ATTY. SUNNY G. SACLA
BAC-INFRA Chairperson

INSTRUCTIONS:

"PLEASE SEAL YOUR QUOTATIONS"

- All Entries must be typewritten or handwritten (please write legibly & do not use pencil);
- To quote for this Contract, a Contractor must meet the following major criteria: (a) Filipino Citizen or 75% Filipino-owned partnership, corporation, cooperative, or joint venture, with PCAB License applicable to the type and cost of this contract;
- Clustered projects shall be treated as one project. Any adverse findings on any of the clustered projects shall be a ground for disqualification.
- All particulars relative to the Evaluation of quotation, Post-Qualification and award of contract shall be governed by the pertinent provision of revised R.A. 9184 and its implementing rules and regulations;
- Documentary requirements to be submitted with this RFQ:
 - Detailed Estimates with pertinent supporting documents (e.g. Summary Sheet)
 - Mayor's/Business Permit;
 - PhilGEPS Registration Number: _____ (Kindly indicate)
 - PCAB License;
 - Latest Income/Business Tax Returns for ABC above P500,000.00;
 - Omnibus Sworn Statement for ABC above P500,000.00; and
**in lieu of 'b' & 'c', certified true copy of PhilGEPS Platinum membership may be submitted.*
- The only authorized person to secure and drop quotations (RFQs) and documents is the contractor himself/herself or his/her representative through a Special Power of Attorney (SPA), particularly stating therein the title of the project/s which the principal (contractor) is granting authority for his/her agent with the power to secure, drop and sign in behalf of the principal any documents required in the procurement proceedings (R.A. 9184);
- Detailed estimate for all items of work shall be itemized (not lumpsum);
- Detailed Estimates for reinforcing steel bars shall be itemized according to its size;
- To submit the following additional documentary requirements within three (3) days from Notice of the BAC:
 - Construction Schedule and S-Curve;
 - Cash Flow;
 - Manpower Utilization Schedule;
 - Equipment Utilization Schedule;
 - Construction Safety and Health Program;
 - Construction Method;
 - PERT-CPM;
 - Provincial Permit;
- All Erasures shall be countersigned;

****Non-compliance to the foregoing instructions shall be a ground for disqualification.**

NO.	PROJECT TITLE	QUANTITY	UNIT	UNIT PRICE	TOTAL PRICE
1	IMPROVEMENT OF JFMR - LLPB - LANAS - PUSONG ROAD, PUSONG, LOO, BUGUIAS				
	SCOPE OF WORK				
	Spl. A Project Billboard	whole	whole		
	Spl. B Construction Health and Safety Requirements	whole	whole		
	Spl. C Mobilization and Demobilization	whole	whole		
	103 Structure Excavation (Common Soil)	37.31	cu.m		
	404 Reinforcing Steel Bar	2,327.28	kgs		
	405 Structural Concrete	17.96	cu.m		
	505(5) Grouted Ripap (Class A)	99.31	cu.m		
	MINIMUM EQUIPMENT REQUIRED	IN FIGURES:			
	1 Cargo Truck (Mobilization & Demobilization)				
	1 Cargo Truck (2-5MT)				
	1 Bar Cutter, Single Phase				
	1 Bar Cutter, Single Phase				

	1	One Bagger Concrete Mixer			
	1	Concrete Vibrator			
	1	Water Truck (1000gal.)			
		Minor Tools			

BID AMOUNT IN FIGURES:

BID AMOUNT IN WORDS:

CANVASSER/S:

CERTIFICATION

This is to certify that I have full knowledge, authority and responsibility in distributing and/or collecting the Request for Quotation in accordance to the guidelines in securing prices for the Bids and Awards Committee on Infrastructure.

CEFERINO GOLINGAB JR. / SEVENTINA C. OWAY
BAC SUPPORT STAFF

After having carefully read and accepted your general conditions.
I/We quote you on the project noted above.

Name of Construction Firm(As indicated in PCAB License) & Address

Name of Owner
(Signature over printed name)

Telephone / Cellphone Number
e-mail Address

Date:

GENERAL NOTES

A. SCOPE OF WORK

- 1. ~~SPL~~ A: FABRICATION & INSTALLATION OF PROJECT BILLBOARD.
- 2. ~~SPL~~ B: CONSTRUCTION HEALTH AND SAFETY REQUIREMENTS
- 3. ~~SPL~~ C: MOBILIZATION AND DEMOBILIZATION
- 4. ~~ITEM~~ 103: STRUCTURE EXCAVATION(Common Soil)
- 5. ~~ITEM~~ 404: REINFORCING STEEL
- 6. ~~ITEM~~ 405: STRUCTURAL CONCRETE(Class "A", 1:2:3, f'c=3,000Psi @ 28days)
- 7. ~~ITEM~~ 505(S): GROUTED RIPRAP(Class A)

B. EQUIPMENTS TO BE USED

- 1. ONE UNIT - CARGO TRUCK(MOBILIZATION AND DEMOBILIZATION)
- 2. ONE UNIT - CARGO TRUCK(2-5MT)
- 1 3. ~~UNIT~~ UNITS - BAR CUTTER, SINGLE PHASE
- 1 4. ~~UNIT~~ UNITS - BAR BENDER
- 5. ONE UNIT - ONE BAGGER CONCRETE MIXER
- 6. ONE UNIT - CONCRETE VIBRATOR
- 7. ONE UNIT - WATER TRUCK (10000GAL.)
- 8. MINOR TOOLS

C. SPECIFICATIONS

- 1. PROJECT BILLBOARD SHALL BE STRICTLY COMPLIED PRIOR TO THE START OF THE PROJECT.
- 2. ALL DIMENSIONS HEREIN ARE IN METERS UNLESS OTHERWISE SPECIFIED.
- 3. WORKMANSHIP SHALL CONFORM TO THE STANDARDS OF THE RESPECTIVE TRADE.
- 4. APPROVED REVISIONS MAYBE DONE HEREIN TO SUIT EXISTING FIELD CONDITIONS.
- 5. OTHER DETAILS NOT SHOWN HEREIN OR NOT CLEARLY UNDERSTOOD SHALL BE REFERRED TO THE PROJECT IN- CHARGE FOR PROPER VERIFICATION AND RECOMMENDATIONS.
- 6. PROVIDE TRAFFIC / WARNING SIGNS AS SAFETY MEASURES.
- 7. AGGREGATES SHALL BE STRICTLY TAKEN FROM THE PROGRAMMED SOURCE.
- 8. IMPLEMENTATION OF CONSTRUCTION HEALTH AND SAFETY REQUIREMENTS (COSH) SHALL BE STRICTLY COMPLIED. WEARING OF PERSONAL PROTECTIVE EQUIPMENT (PPE) IS A MUST DURING THE START OF PROJECT. DESIGNATE SAFETY OFFICER AND FIRST AIDER ON SITE.

*MINIMUM PERSONAL PROTECTIVE EQUIPMENT (PPE) FOR COSH

- a. Safety Shoes
- b. Helmet/ Skull Guard
- c. Safety Gloves
- d. ReflectORIZED Vest
- e. First Aid Kit
- f. DOH Approved Face Mask
- g. Medical Kits (Sanitizer, Alcohol, Thermal Scanner, Etc.)

REINFORCING STEEL







- 1. REINFORCING STEEL BARS TO BE USED SHALL CONSIST OF NEW BILLET STEEL (STRUCTURAL GRADE) OF GOOD QUALITY, MEETING ALL THE REQUIREMENT OF THE STANDARD SPECIFICATIONS FOR REINFORCING BARS, AND THE SIZE REQUIRED BY THE DRAWING. (fy=276mpa; G=40)
- 2. THE LENGTH OF LAP JOINT AND ANCHORAGE SHALL NOT BE LESS THAN 40 TIMES THE DIAMETER OF THE BAR BUT NOT LESS THAN 300mm.


STRUCTURAL CONCRETE

- 1. AGGREGATES TO BE USED HEREIN SHALL BE HARD, DURABLE, CLEAN AND FREE FROM HARMFUL MATTERS THAT ARE INJURIOUS TO CONCRETE.
- 2. CONCRETE MIXTURE FOR STRUCTURAL CONCRETE AND ALL REINFORCED STRUCTURES SHALL BE CLASS "A"(1:2:3) F'c=3,000PSI @ 28 CD.
- 3. PROVIDE ENOUGH FORM SUPPORT AND SCAFFOLDINGS FOR STRUCTURAL CONCRETE PRIOR TO CONCRETE POURING TO AVOID BUCKLING & BULGING OF STRUCTURES.

GROUTED RIPRAP


- 1. STONE BOULDERS FOR GROUTED RIPRAP SHALL BE HARD, DURABLE AND SHALL PASS QUALITY CONTROL STANDARDS.
- 2. MORTAR MIXTURE FOR GROUTED RIPRAP SHALL BE CLASS "A" (1:3).
- 3. GROUTED RIPRAP SHALL BE PROVIDED W/ 3" DIA. PVC PIPE WEEPHOLES SPACED AT 1.00M O.C. ON STAGGERED BASIS.
- 4. THE HORIZONTAL AND VERTICAL CONTACT SURFACE BETWEEN STONES SHALL BE EMBEDDED BY CEMENT MORTAR HAVING A MINIMUM THICKNESS OF 20MM. SUFFICIENT MORTAR SHALL BE USED TO COMPLETELY FILL ALL VOIDS LEAVING THE FACE OF THE STONES EXPOSED.
- 5. BOULDERS TO BE USED SHALL BE ~~CLASS "A"~~ **CLASS "A"** ~~1:3~~ **1:2:3**.

<p>PROVINCE OF BENGUET</p>  <p>WANGAL LA TRINIDAD</p>	<p>PROJECT TITLE/LOCATION: IMPROVEMENT OF JFMR-LLPB-LANAS-PUSONG ROAD, PUSONG, LOO, BUGUIAS</p>	<p>PREPARED BY:  SHANE D. ANASAN ENGINEERING ASSISTANT</p>	<p>CHECKED BY:  ENGR. JOSEPH LAY AMAN ENGINEER IV</p>	<p>REVIEWED BY:  ENGR. FRANCISCO T. BANGOYAO ASSISTANT PROFESSIONAL ENGINEER</p>	<p>APPROVAL RECOMMENDED BY:  ENGR. JERRY L. BOCANO PROVINCIAL ENGINEER</p>	<p>APPROVED BY:  MELCHOR D. DICALAS, MD PROVINCIAL GOVERNOR</p>	<p>SHEET NO.: 1 / 6</p>
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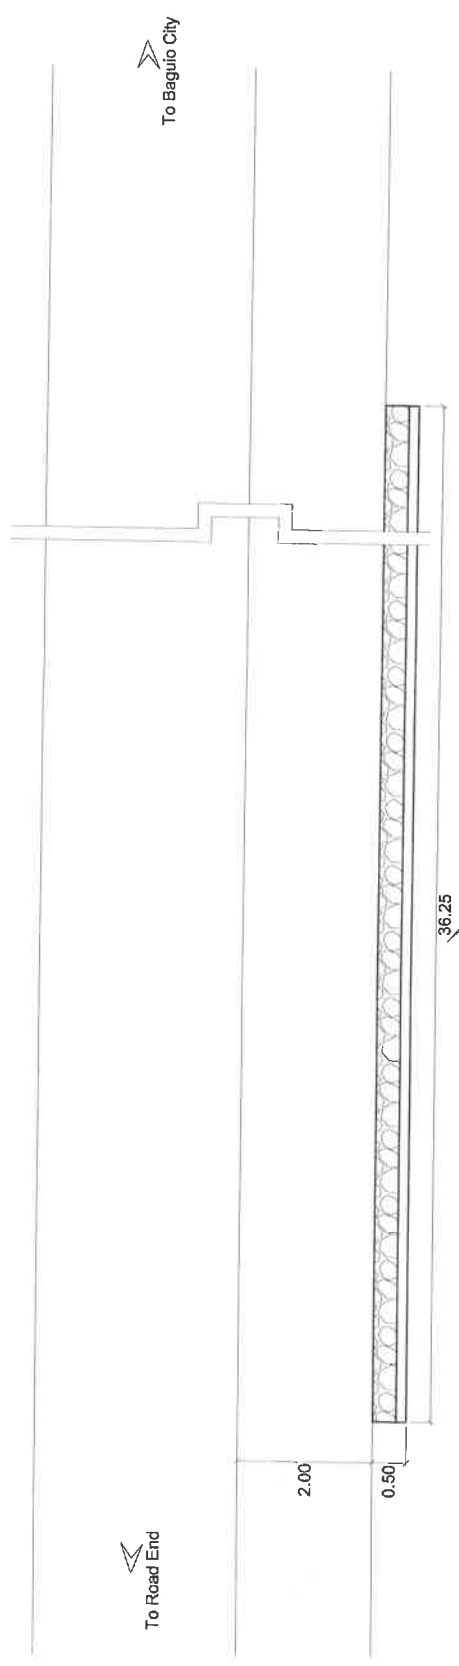


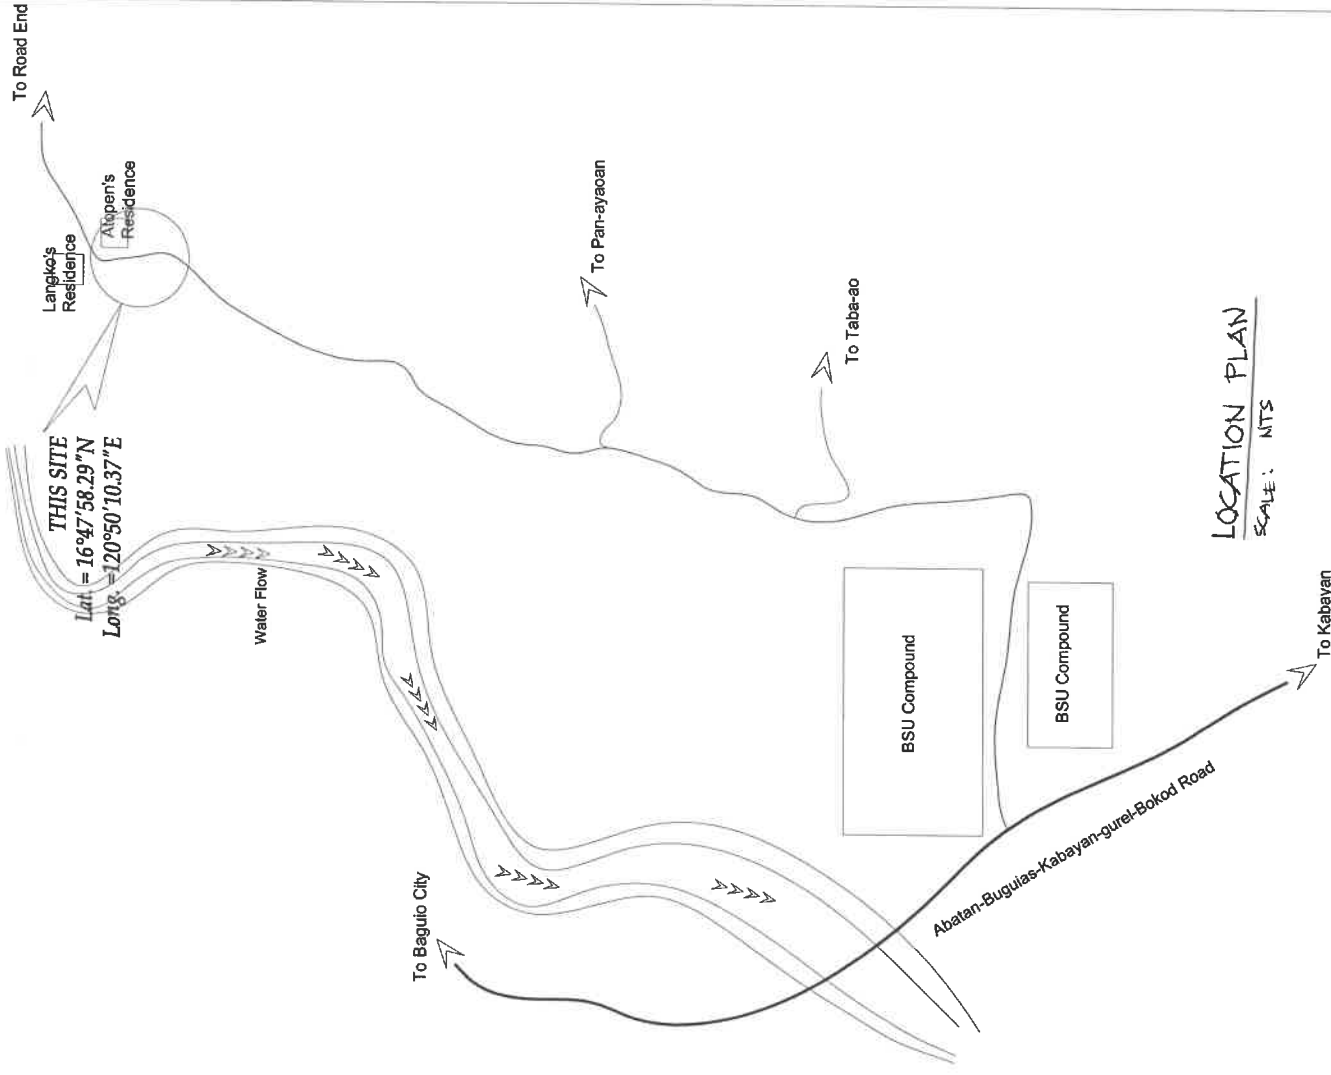LOCATION PLAN
SCALE: NTS


PROVINCE OF BENGUET	PROJECT TITLE/LOCATION:	PREPARED BY:
PEO	IMPROVEMENT OF JFMR-LLPB-LANAS-PUSONG ROAD, PUSONG, LOO, BUGUIAS	
WANGAL, LA TRINIDAD	BUGUIAS, BENGUET	SHANE D. ANASAN ENGINEERING ASSISTANT

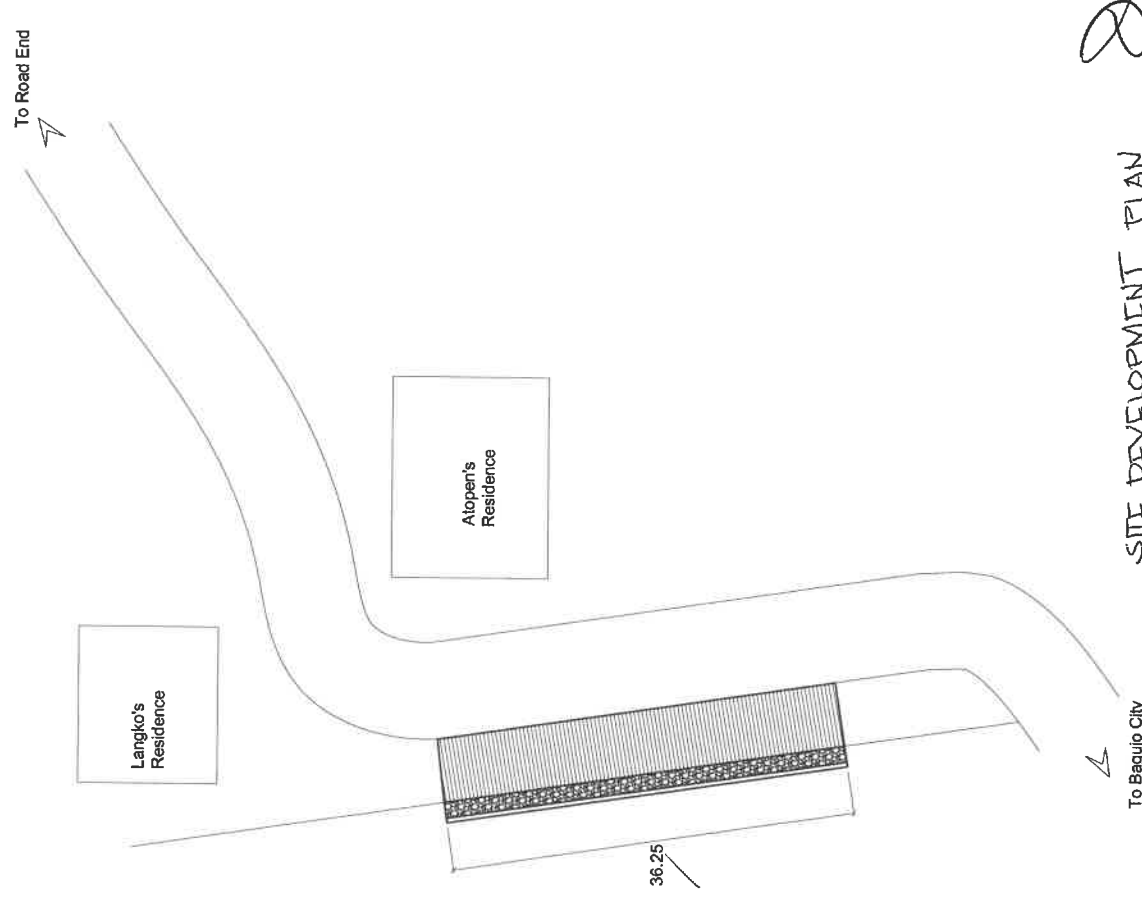

SITE DEVELOPMENT PLAN
SCALE: NTS



36.25
PLAN
SCALE: 1:50

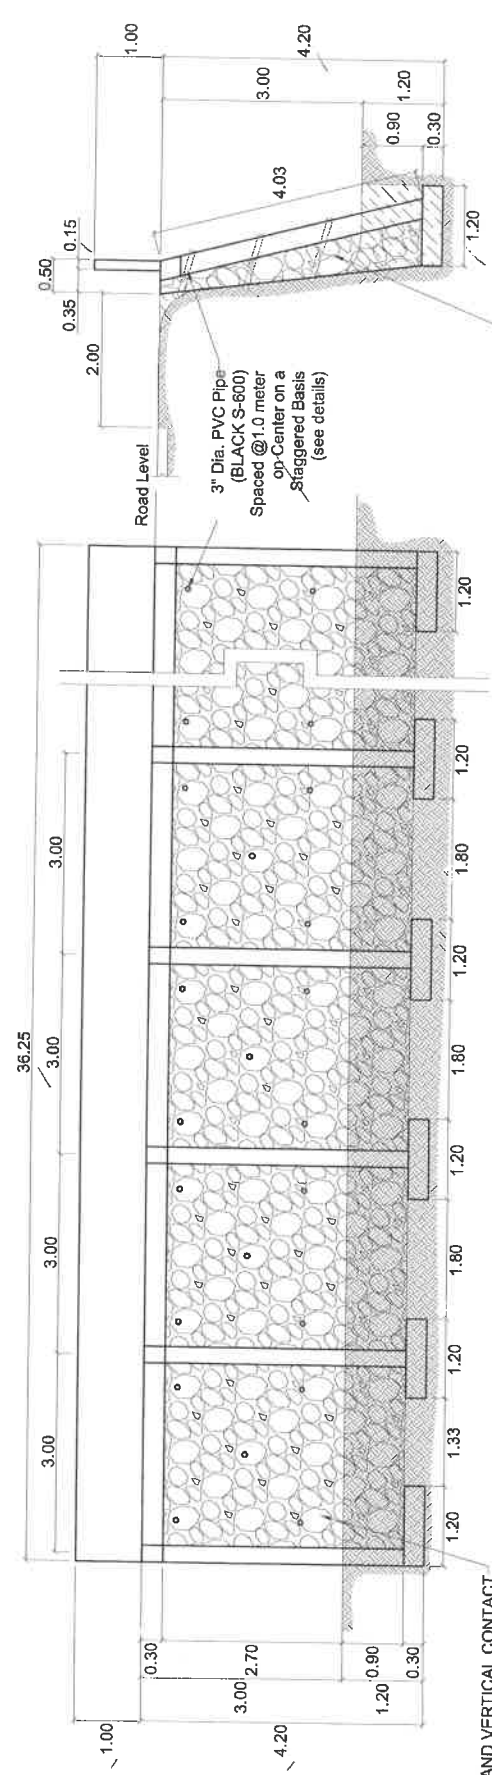

ELEVATION
SCALE: 1:50

THE HORIZONTAL AND VERTICAL CONTACT SURFACE BETWEEN STONES SHALL BE EMBEDDED BY CEMENT MORTAR HAVING A MINIMUM THICKNESS OF 20MM. SUFFICIENT MORTAR SHALL BE USED TO COMPLETELY FILL ALL VOIDS LEAVING THE FACE OF THE STONES EXPOSED.


ELEVATION
SCALE: 1:50

Note: Total of 13 Columns






THE HORIZONTAL AND VERTICAL CONTACT SURFACE BETWEEN STONES SHALL BE EMBEDDED BY CEMENT MORTAR HAVING A MINIMUM THICKNESS OF 20MM. SUFFICIENT MORTAR SHALL BE USED TO COMPLETELY FILL ALL VOIDS LEAVING THE FACE OF THE STONES EXPOSED.

PREPARED BY:
Shane D. Anasan
SHANE D. ANASAN
ENGINEERING ASSISTANT


PROVINCE OF BENGUET	PROJECT TITLE/LOCATION:	PREPARED BY:
PEO	IMPROVEMENT OF JFMR-LLPB-LANAS-PUSONG ROAD, PUSONG, LOO, BUGUIAS	<i>Shane D. Anasan</i> SHANE D. ANASAN ENGINEERING ASSISTANT
WANGAL LA TRINIDAD	BUGUIAS, BENGUET	

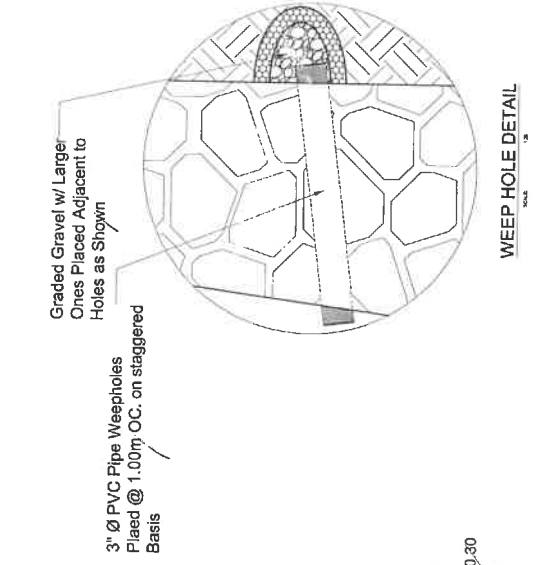

WEEP HOLE DETAIL

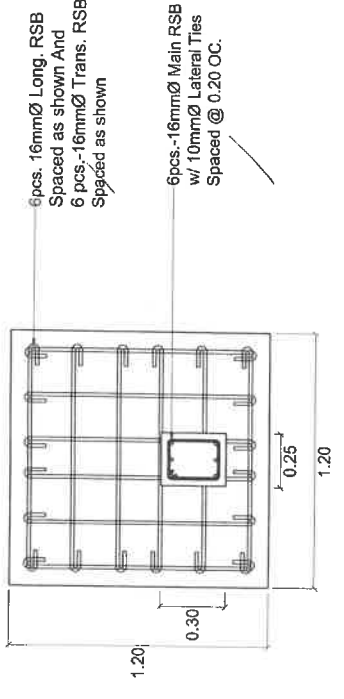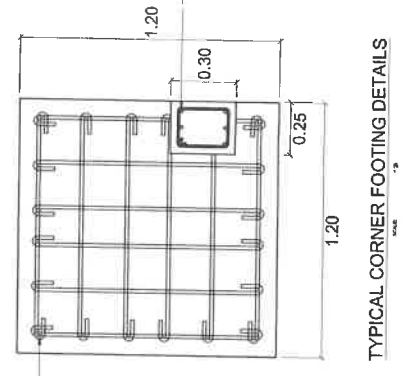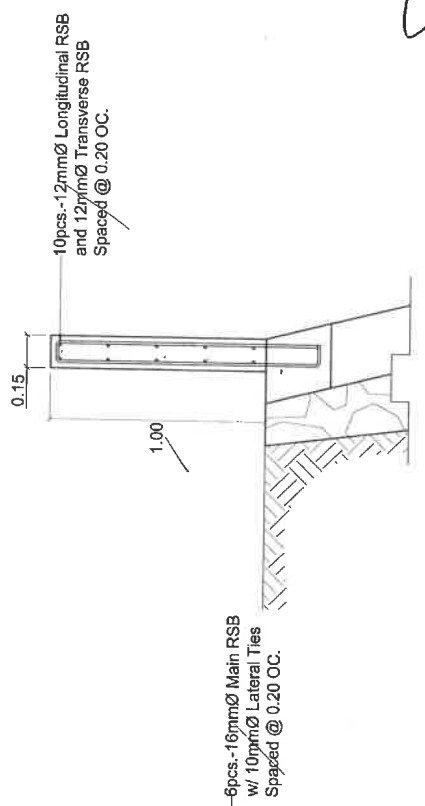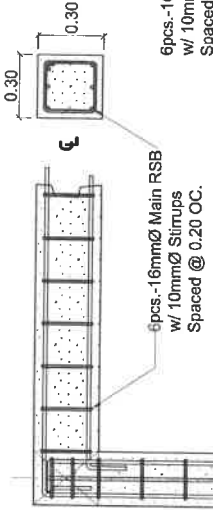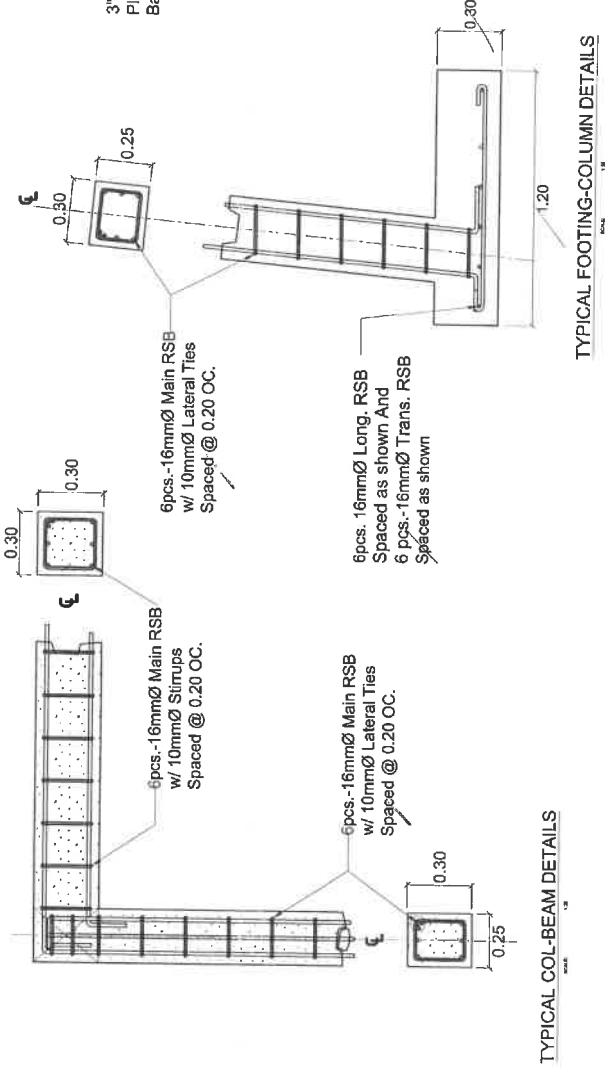


PROVINCE OF BENGUET	PROJECT TITLE/LOCATION:	PREPARED BY:
	IMPROVEMENT OF JFMR-LIPB-LANAS-PUSONG ROAD, PUSONG, LOO, BUGUIAS	 SHANE D. ANASAN ENGINEERING ASSISTANT
	WANGAL, LA TRINIDAD	

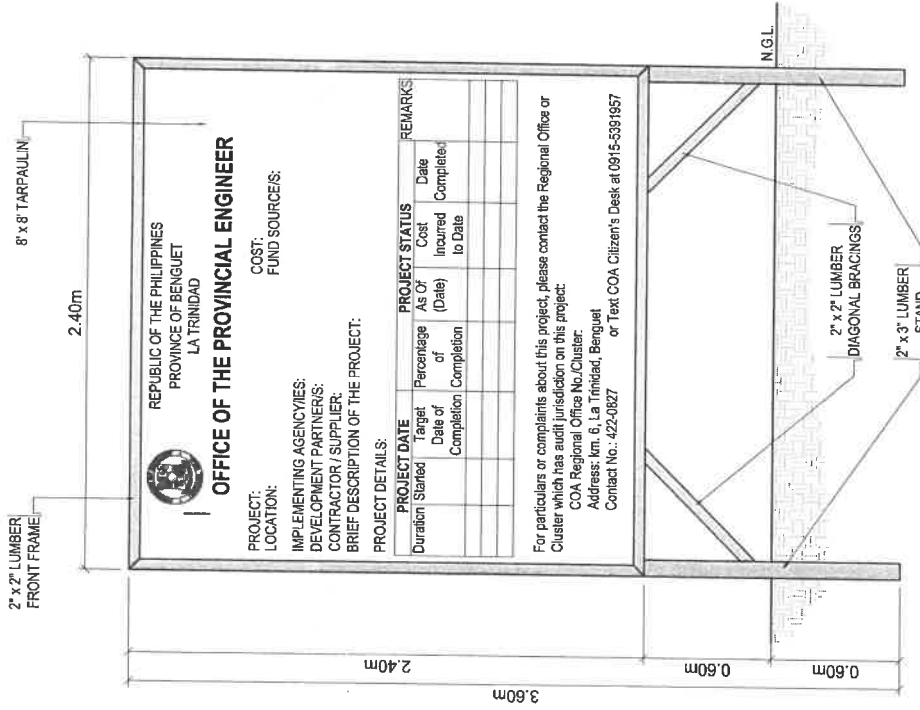


FRONT ELEVATION

NOTE:

- TARPAULIN : WHITE -8FT x 8FT
- RESOLUTION : 70 dpi
- FONT : HELVETICA
- FONT SIZE : MAIN INFORMATION - 3"
- SUB-INFORMATION : 1"
- FONT COLOR : BLACK

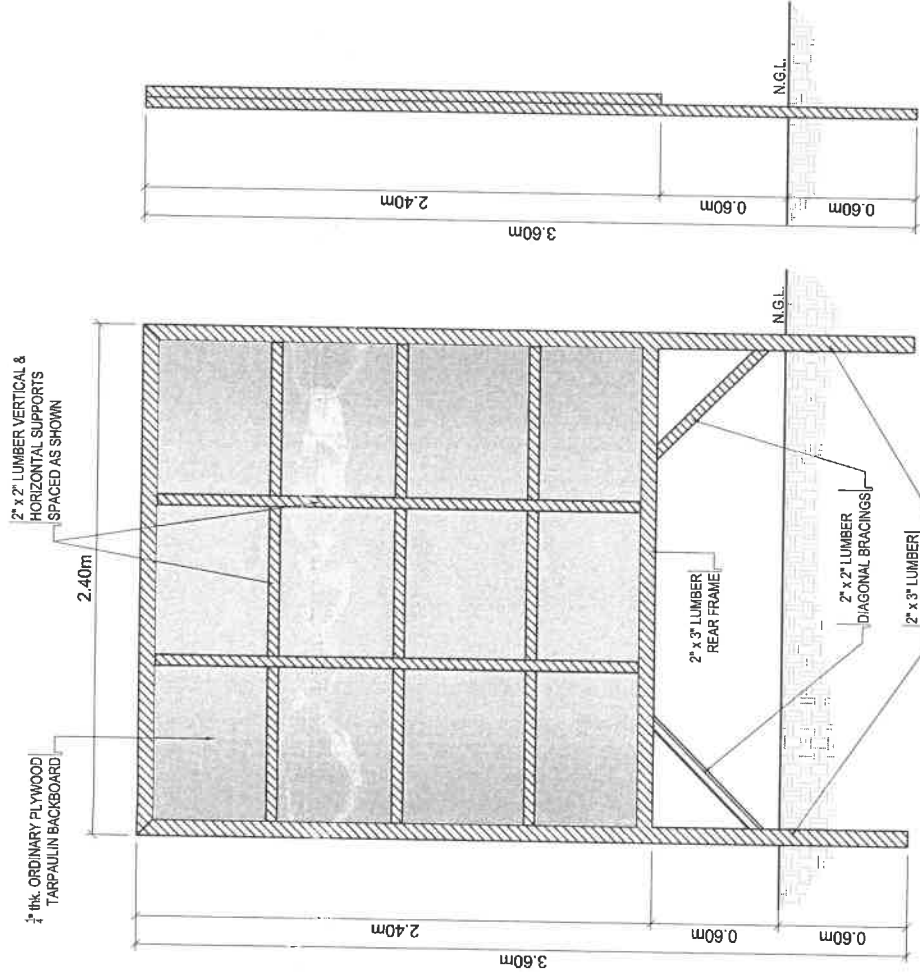

REAR ELEVATION

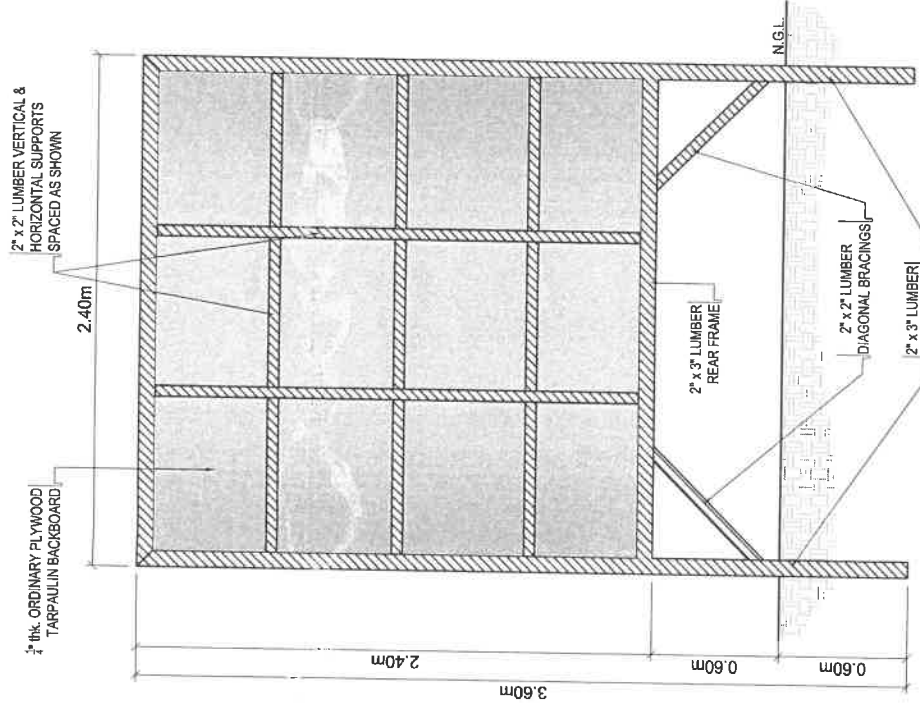

SIDE ELEVATION

	PROVINCE OF BENGUET	PROJECT TITLE/LOCATION:	PREPARED BY:
	WANGAL, LA TRINIDAD	IMPROVEMENT OF JFMR-LLPB-LANAS-PUSONG ROAD, PUSONG, LOO, BUGUIAS	 SHANE D. ANASAN ENGINEERING ASSISTANT

PROPOSED PROJECT BILLBOARD w/ STAND

NOT DRAWN TO SCALE

SHEET NO.:

5 6



2

GOOGLE MAP

PROVINCE OF BENGUET	PROJECT TITLE/LOCATION:	PREPARED BY:
PBO	IMPROVEMENT OF JFMR-ILPB-LANAS-PUSONG ROAD, PUSONG, LOO, BUGUIAS	 SHANE D. ANASAN ENGINEERING ASSISTANT
WANGAL, LA TRINIDAD	BUGUIAS, BENGUET	

2 A

SHEET NO:
6 6

Google Earth

Image © 2002, Map data © 2002, Imagery © 2002, 2004, 2006

1 km

